
FOUR SEASONS SUNROOMS


MONTEITH SUNROOM SILO

5749 WOODHULL ROAD, LONDON ONTARIO

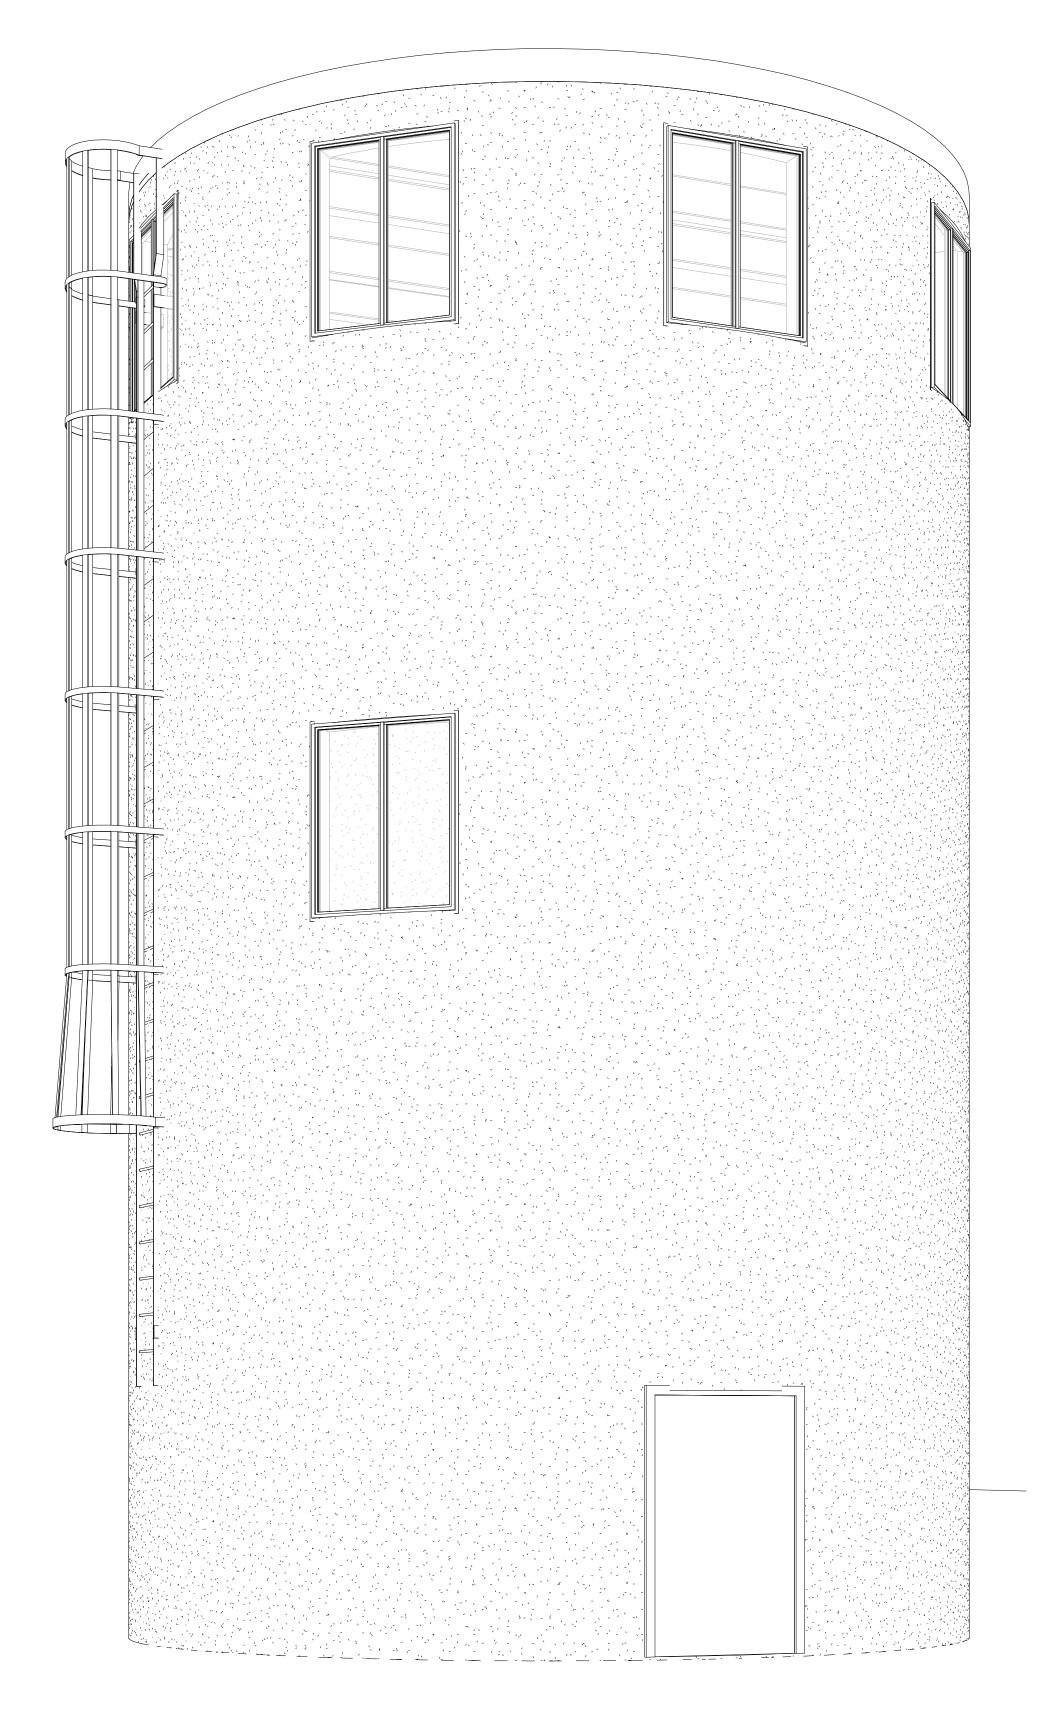

SHEET SCHEDULE			
SHEET NO.	SHEET NAME		
S-0	COVER SHEET		
S-1	FOUNDATION/GROUND FLOOR PLAN		
S-2	LEVELS 1 & 2/ROOF FRAMING PLAN		
S-3	BUILDING SECTION/ WALL SECTION/ NORTH ELEVATION		
S-4	ELEVATIONS		

DESIGNLOGIX ENGINEERING INC. AGRICULTURE - COMMERCIAL - RESIDENTIAL P: 905-512-2377	
E: office@dlxengineering.com DO NOT SCALE DRAWINGS	
ALL DIMENSIONS AND ELEVATIONS TO BE VERIFIED BY THE CONTRACTOR AND ANY DISCREPENCIES REPORTED TO THE ENGINEER	

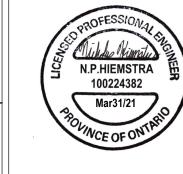

PROJECT STATUS:			
NO:	DATE:	STATUS:	
5	FEB. 23, 2021	FOR CONSTRUCTION	L
6	MARCH 15, 2021	FOR CONSTRUCTION	P
7	MARCH 30, 2021	FOR CONSTRUCTION	
4	JAN. 5, 2021	FOR STAIR COORDINATION	

FOUR SEASONS SUNROOMS
775 WHARNCLIFFE ROAD SOUTH,
LONDON ONTARIO

MONTEITH SUNROOM SILO
5749 WOODHULL ROAD,
LONDON ONTARIO

Date


OCTOBER 13, 2020


Scale


NORTH: TRUE NORTH: Project #: DLX20-439
Drawn by: M.L.


Checked by

COVER SHEET S-0

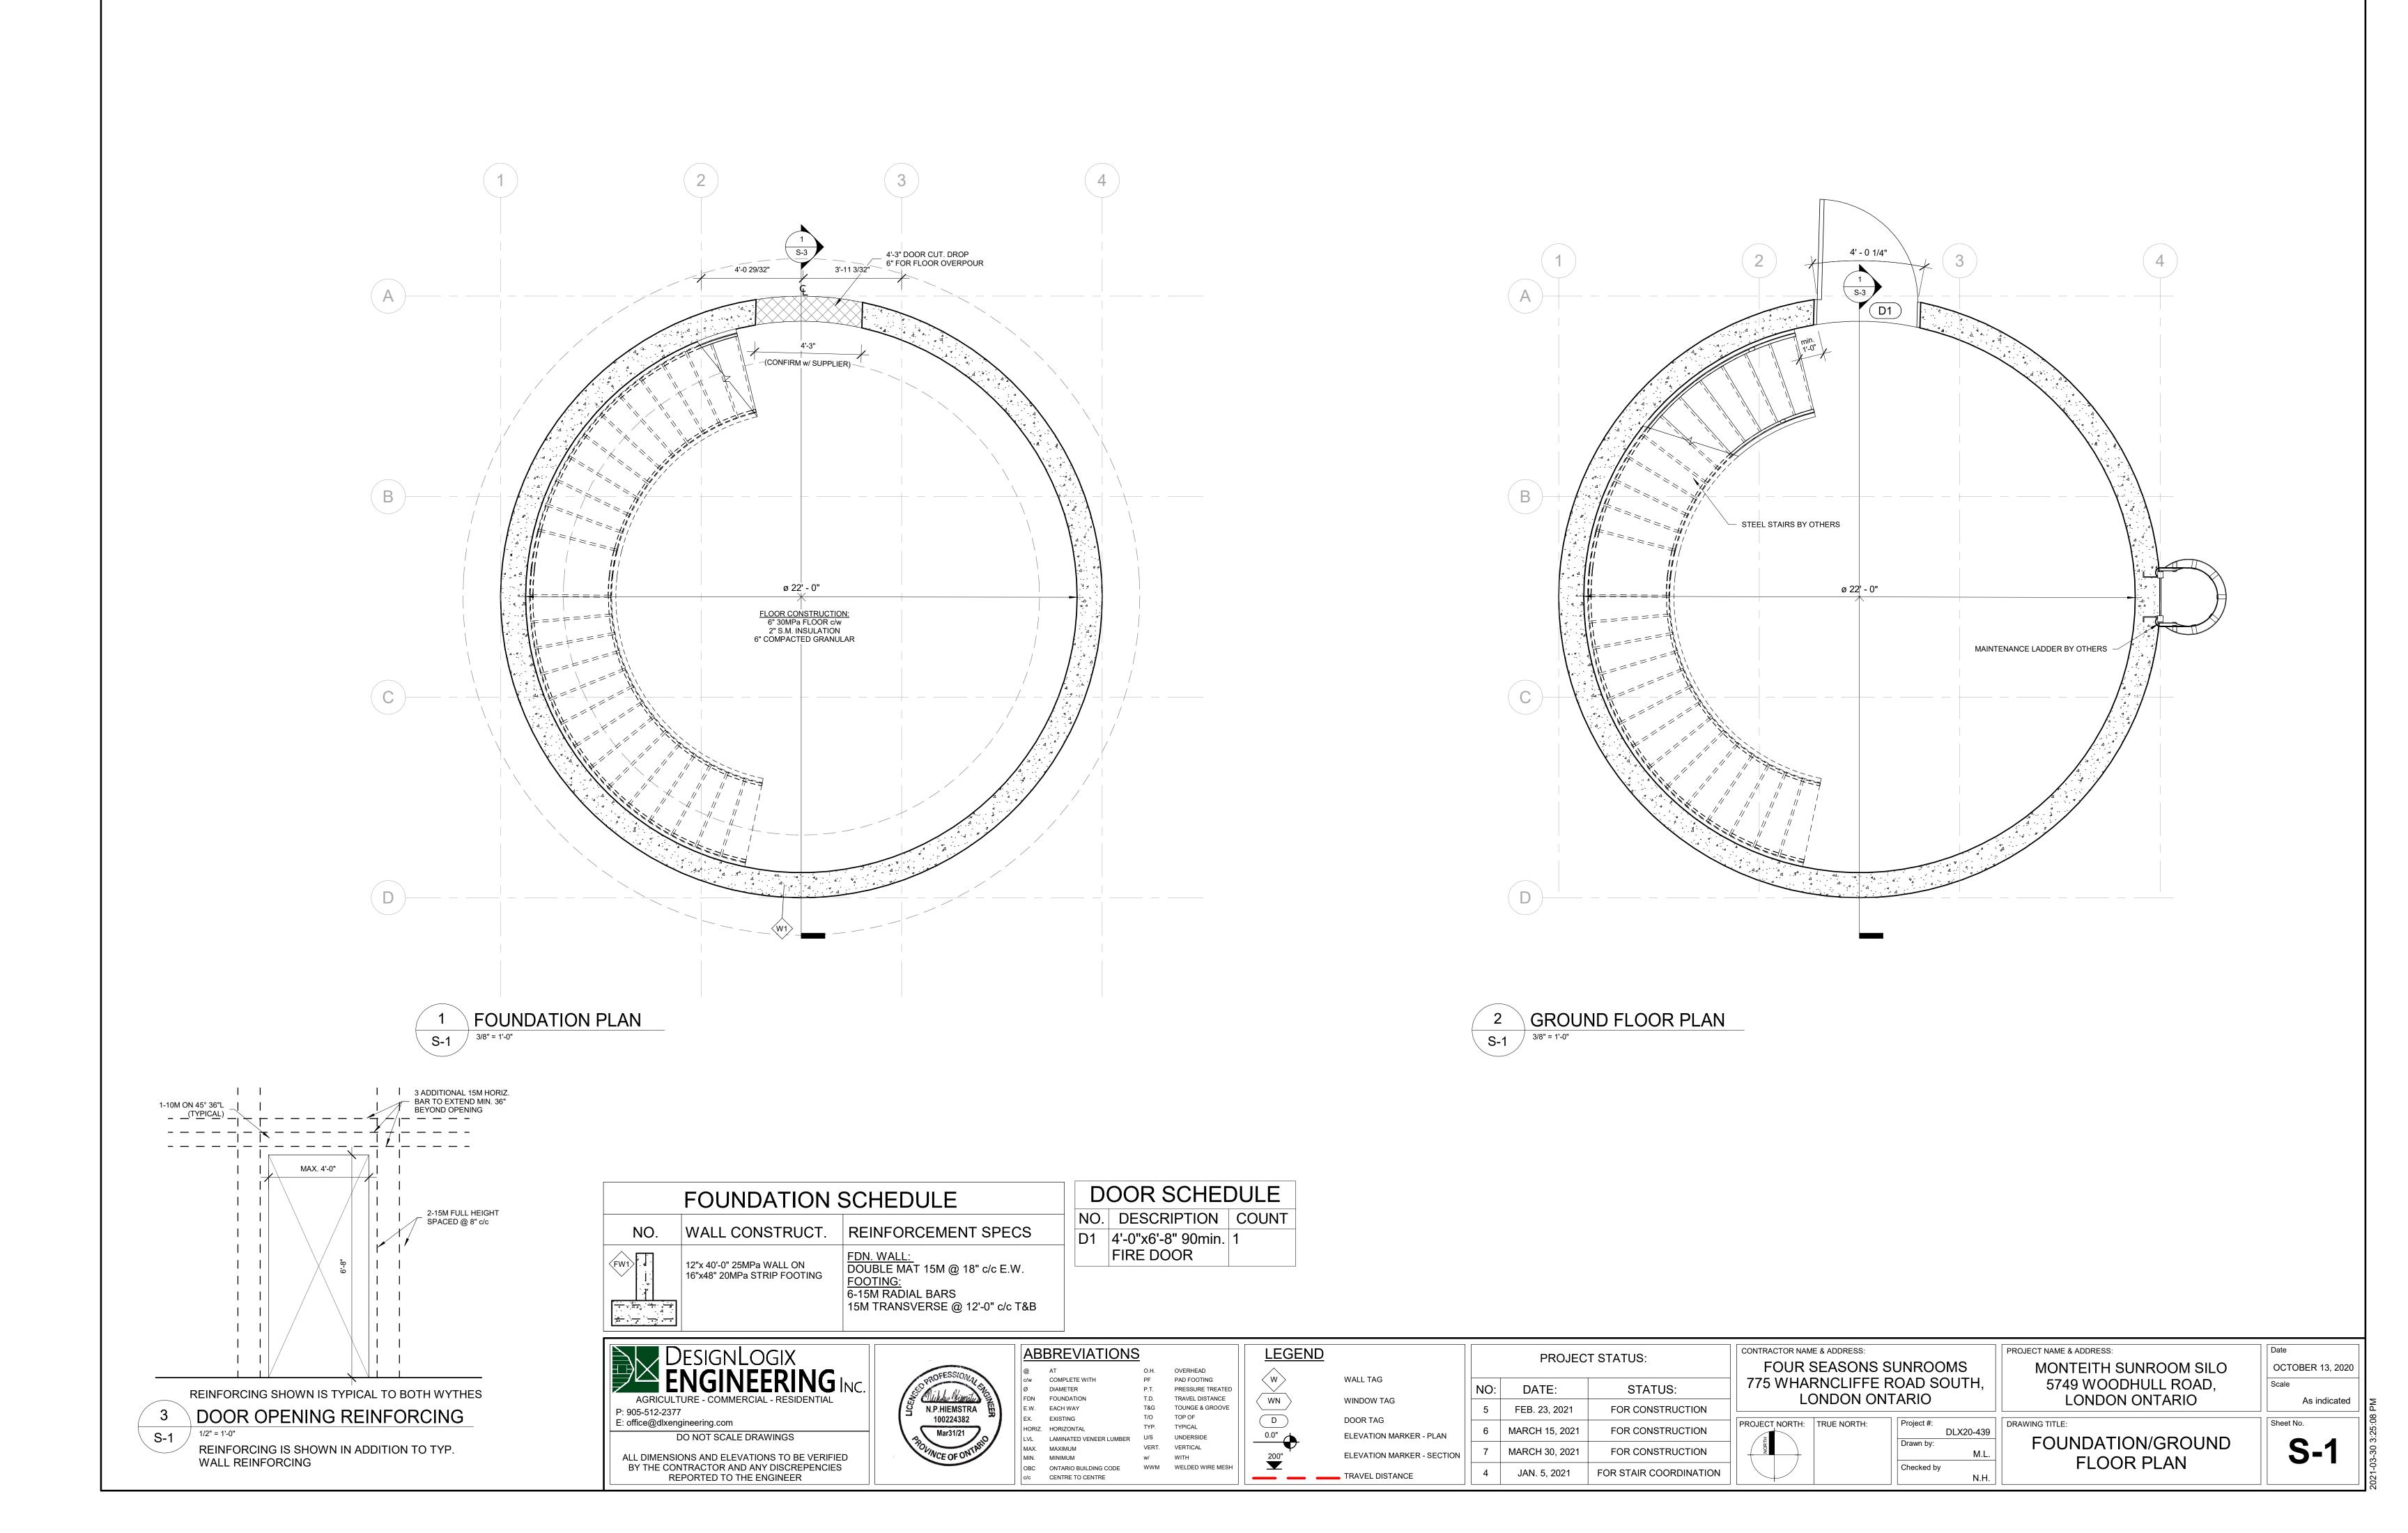

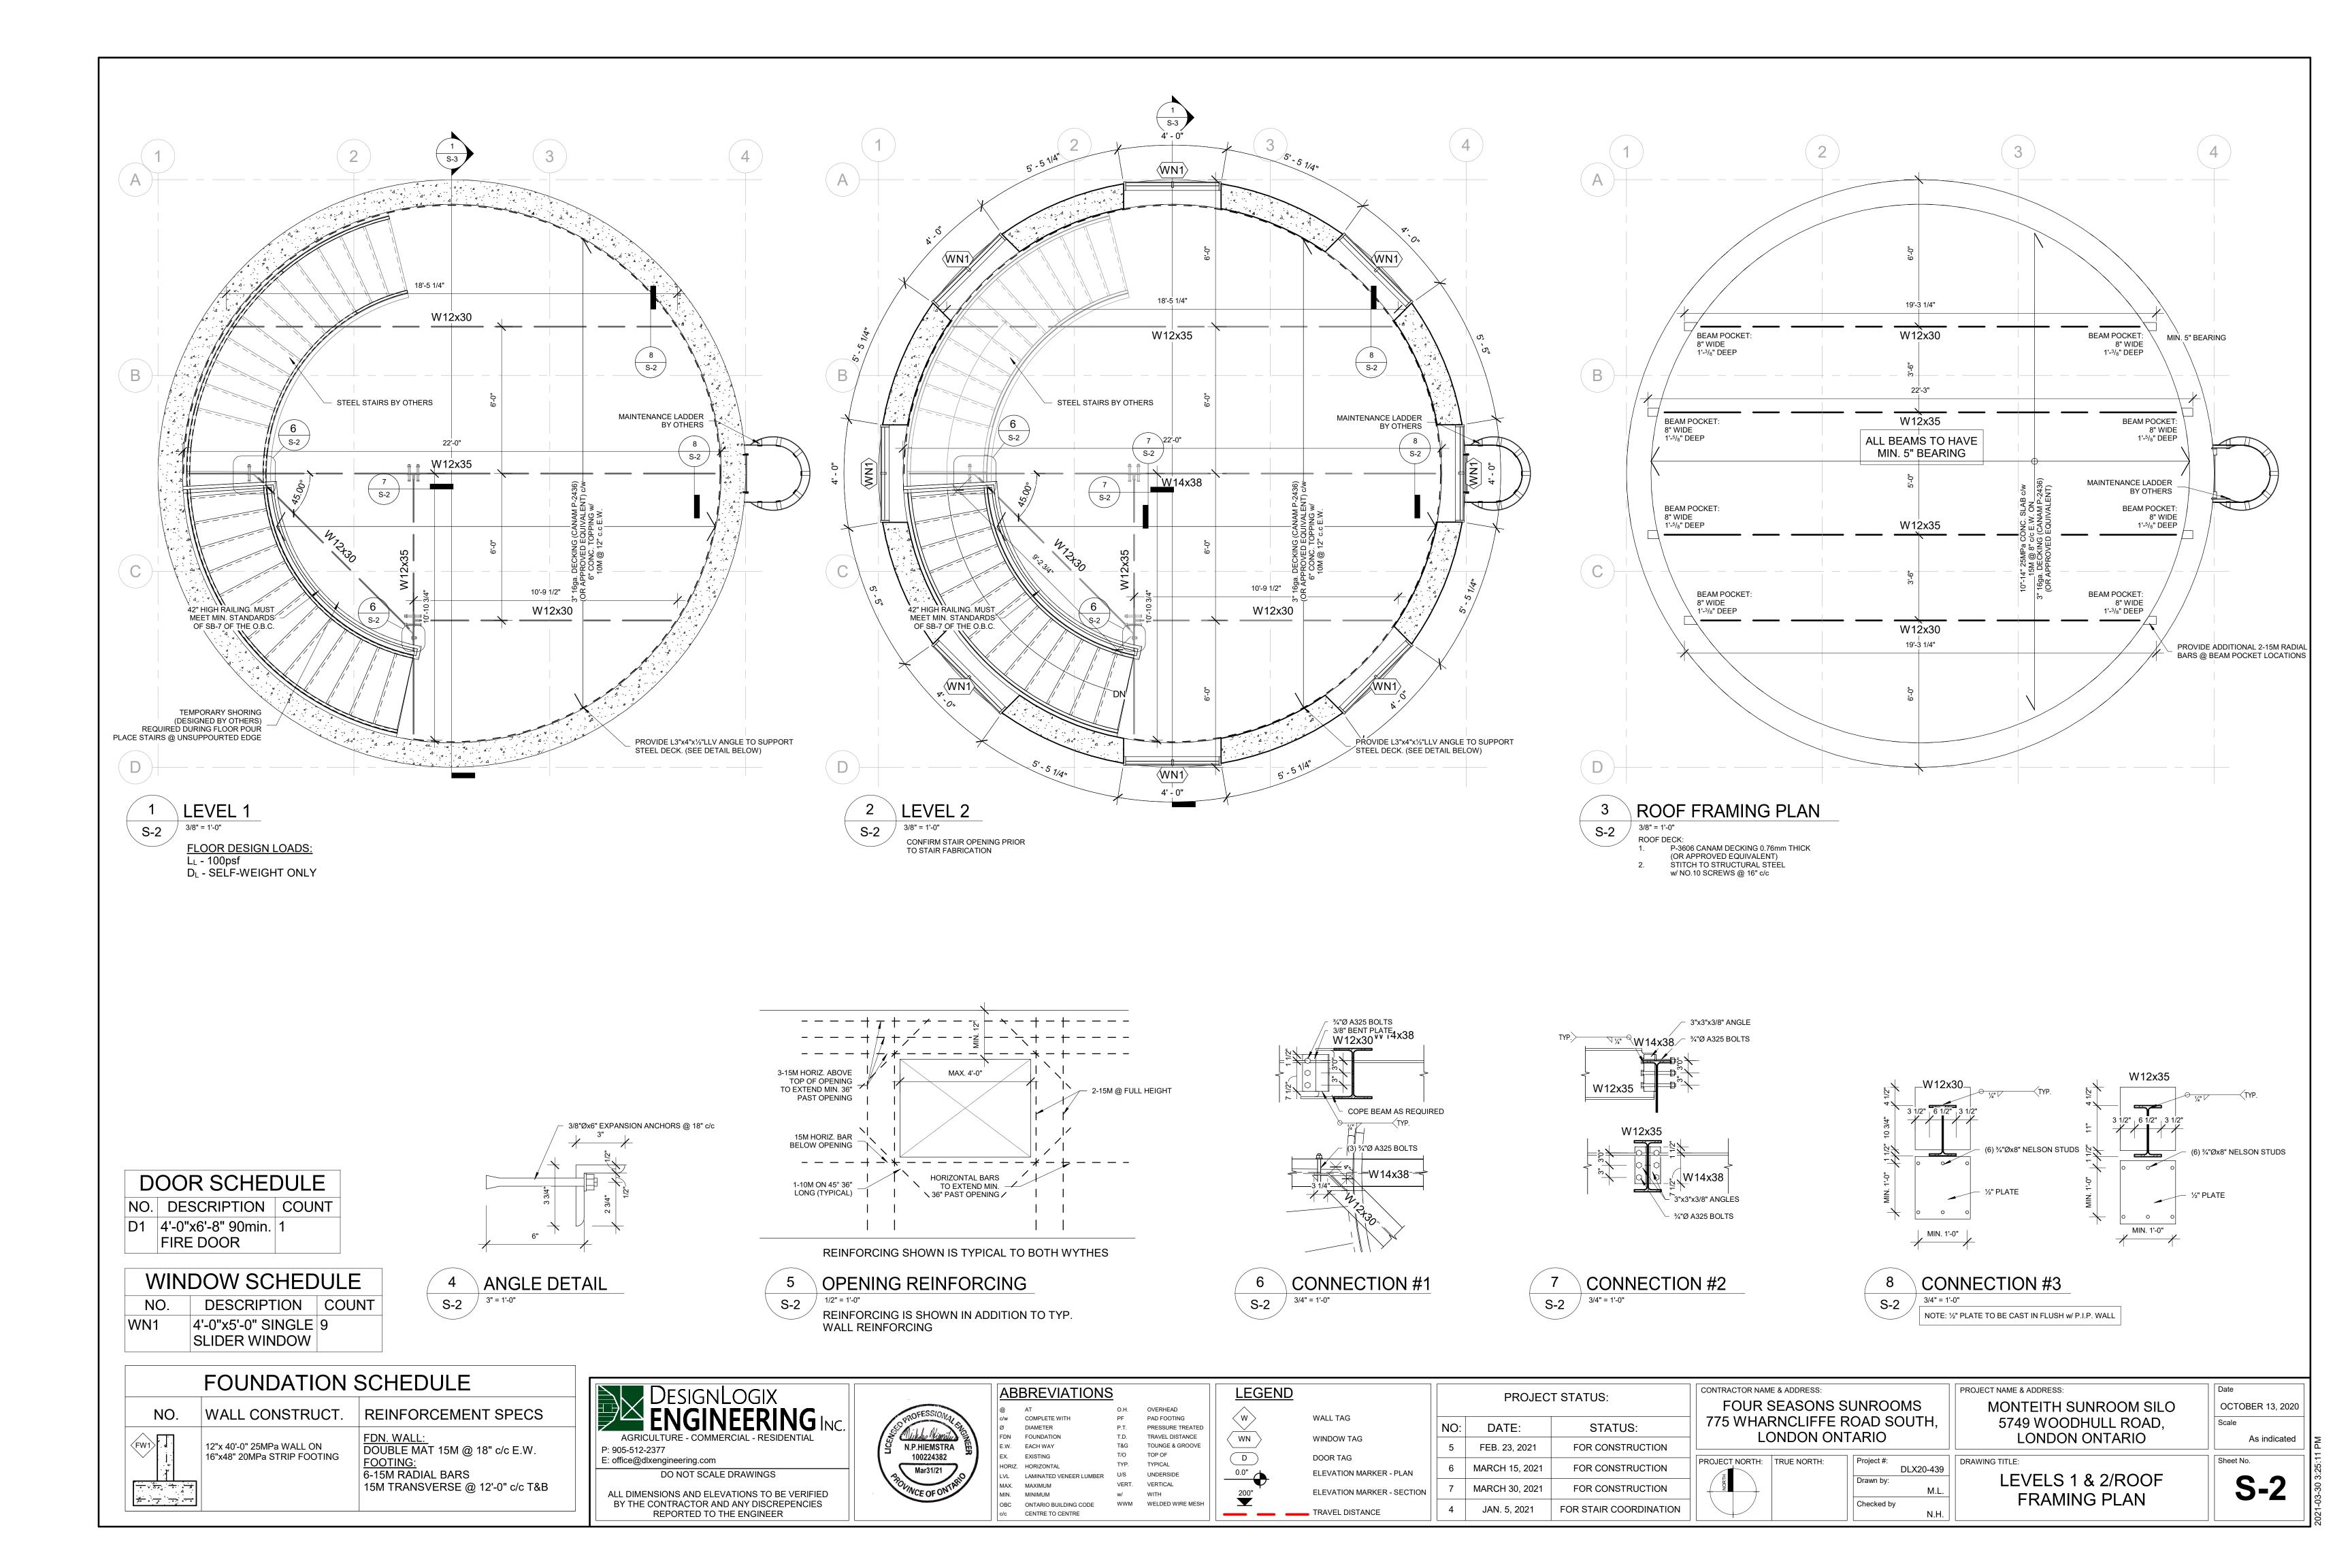

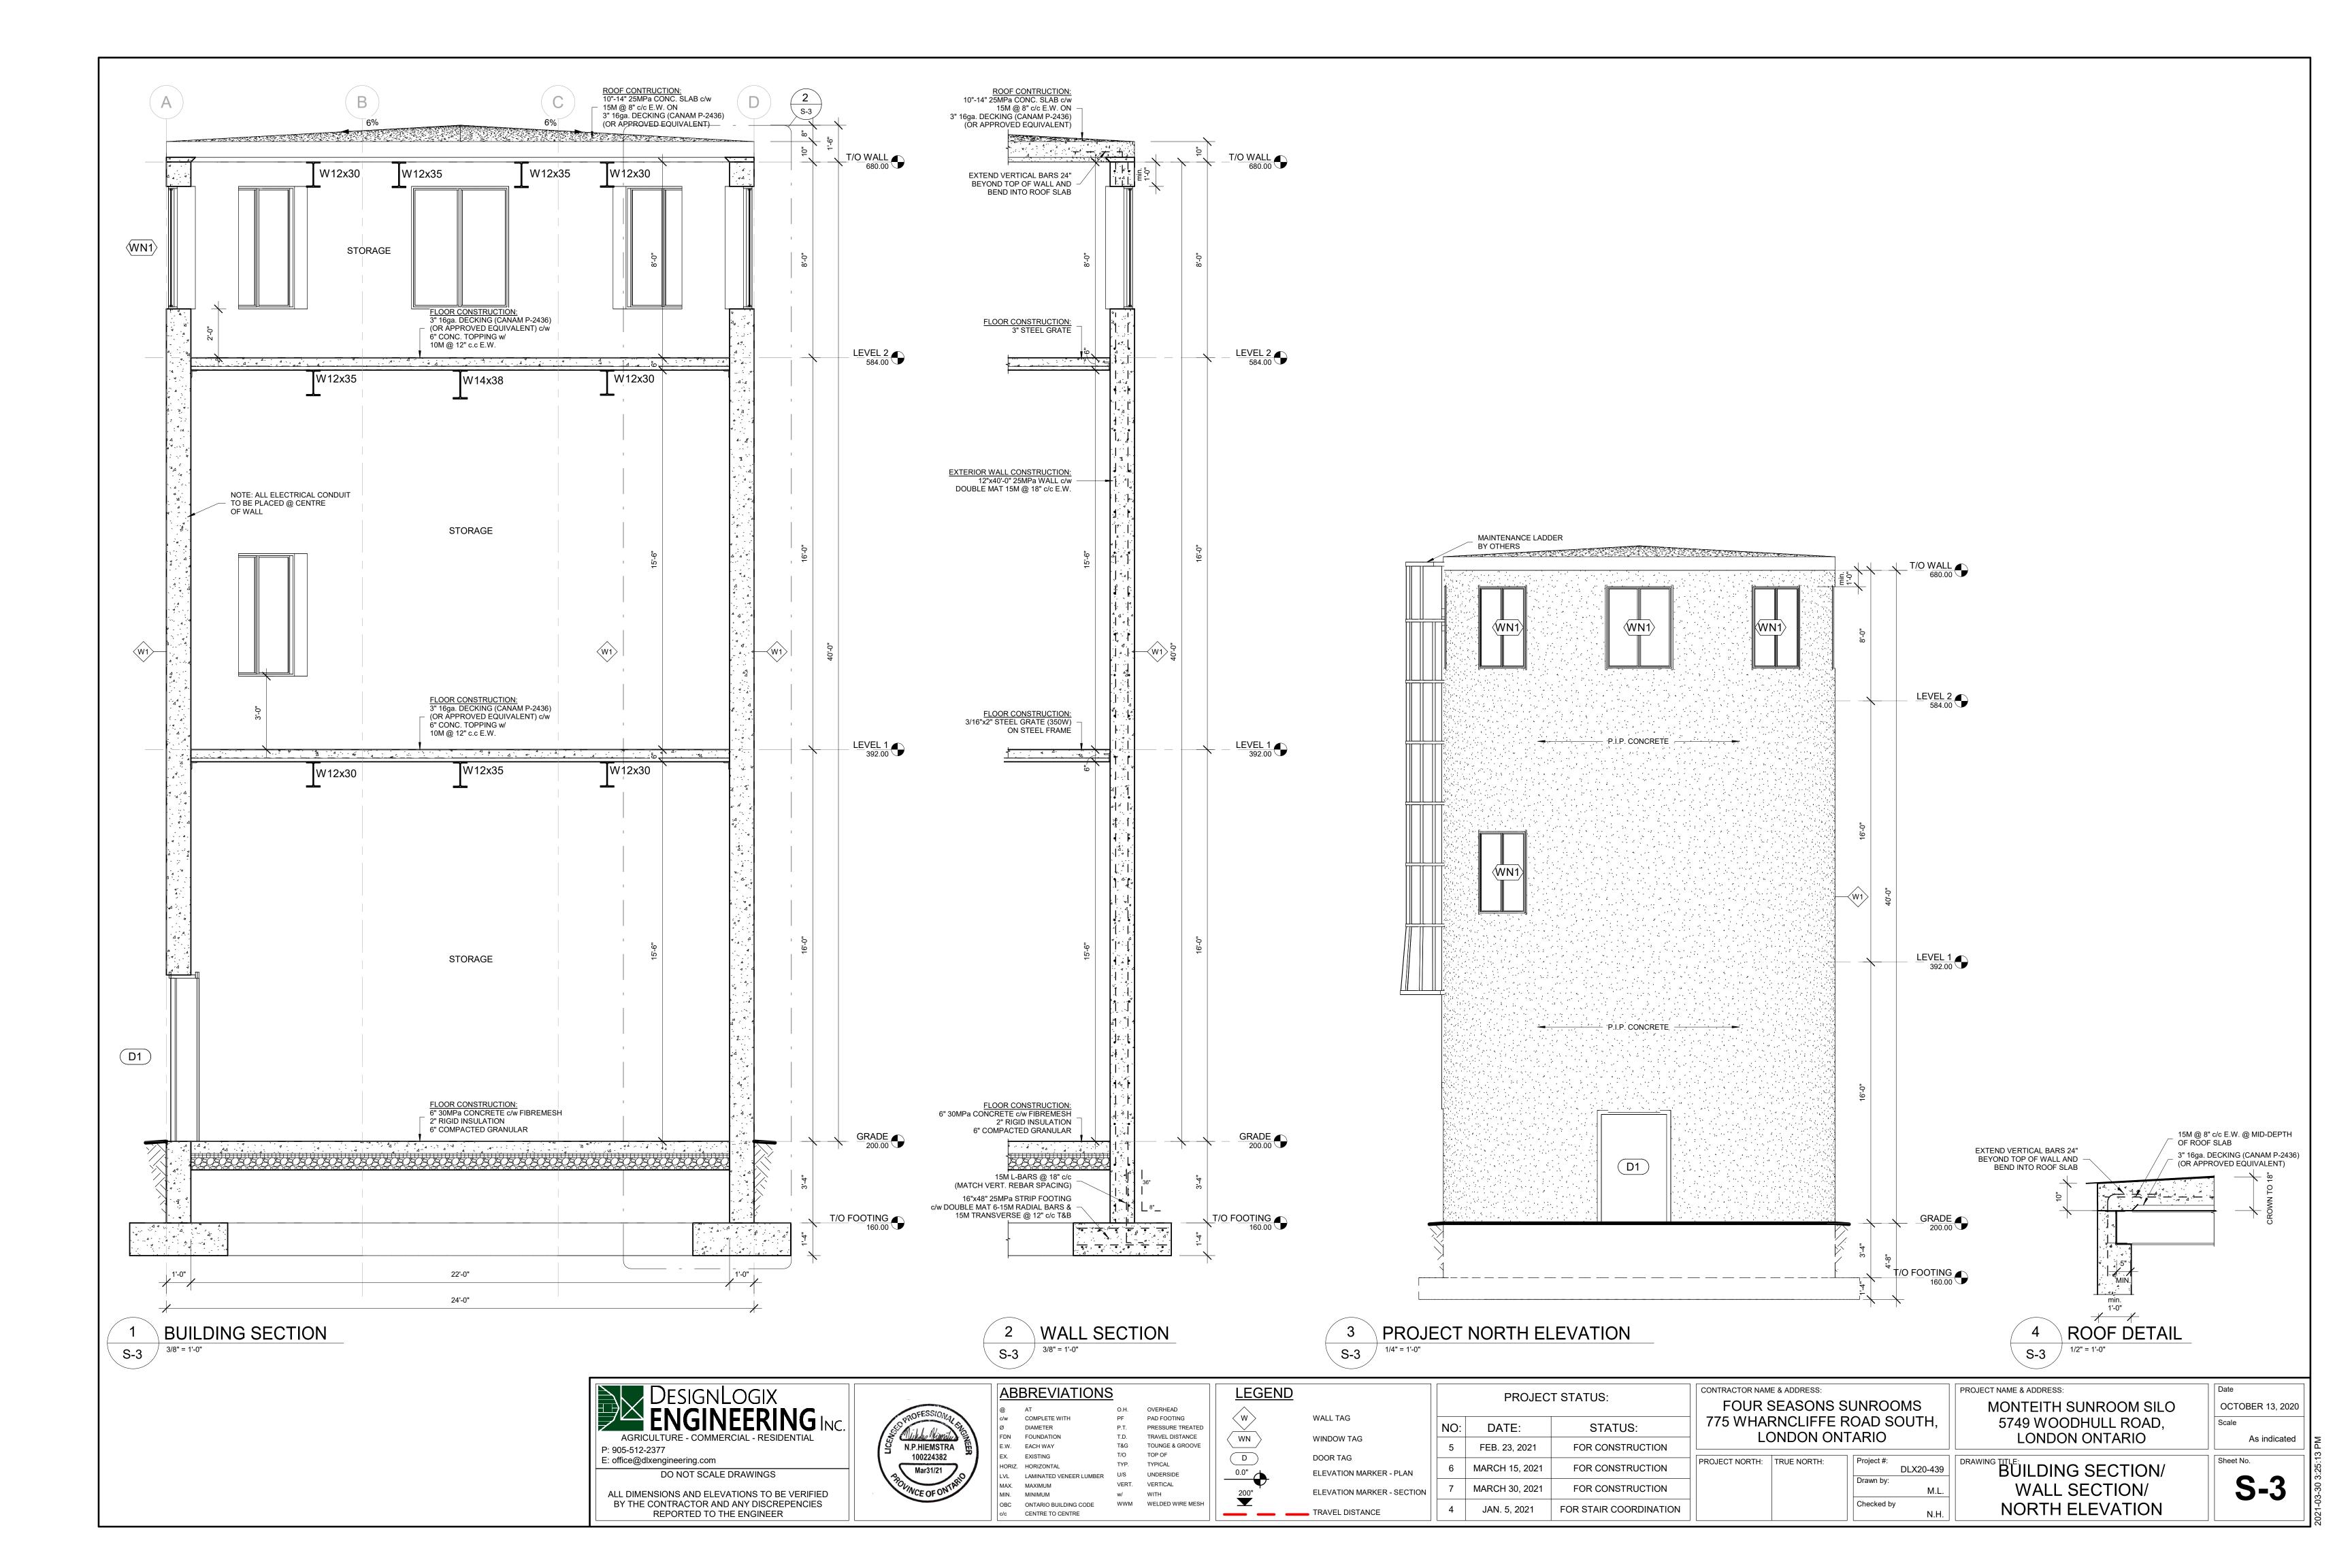

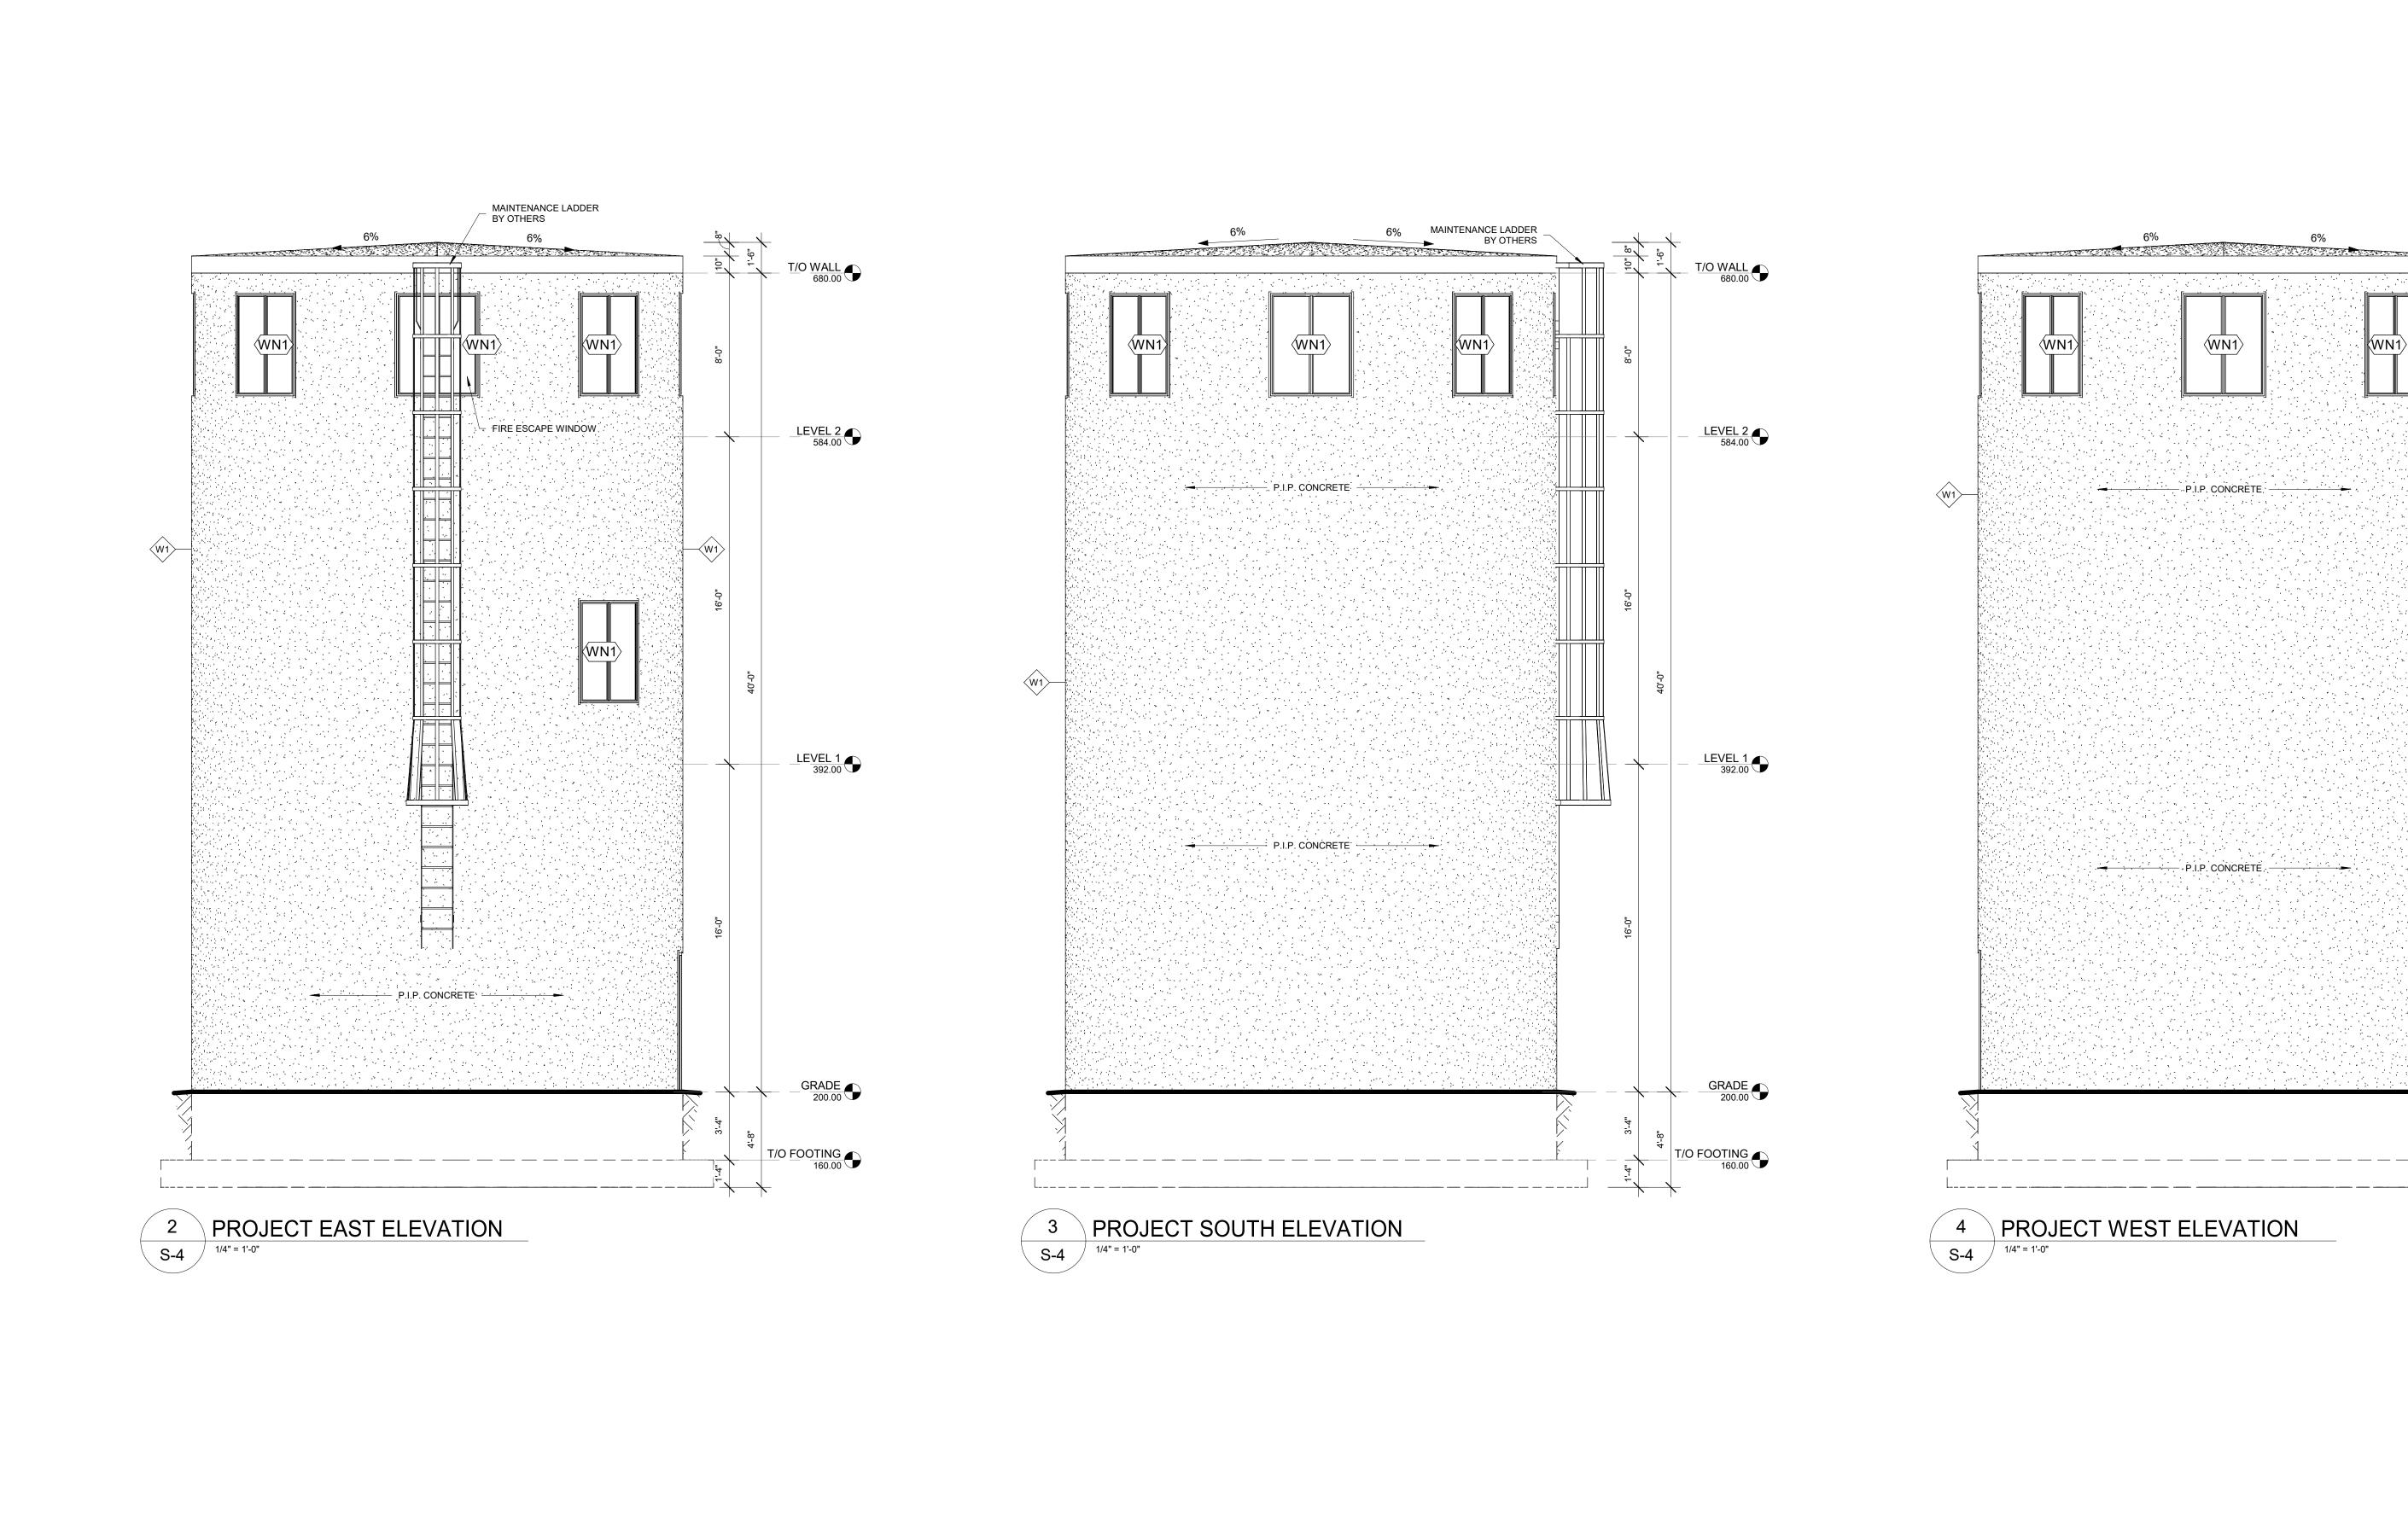

775 WHARNCLIFFE ROAD SOUTH, LONDON ONTARIO

PROJECT NORTH: TRUE NORTH:

DLX20-439
Drawn by:

M.L.
Checked by
N.H.

DRAWING TITLE:

ELEVATIONS

Scale

1/4" = 1'-0"

Sheet No.

MONTEITH SUNROOM SILO

PROJECT NAME & ADDRESS:

CONTRACTOR NAME & ADDRESS:

FOUR SEASONS SUNROOMS

PROJECT STATUS:

DATE:

FEB. 23, 2021

MARCH 15, 2021

MARCH 30, 2021

4 JAN. 5, 2021

STATUS:

FOR CONSTRUCTION

FOR CONSTRUCTION

FOR CONSTRUCTION

FOR STAIR COORDINATION

__LEVEL 1 _______

T/O FOOTING 160.00


OCTOBER 13, 2020

ENGINEERING NC.


AGRICULTURE - COMMERCIAL - RESIDENTIAL
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GENERAL NOTES:

D) LOCAL REGULATIONS

- 1. THIS BUILDING IS DESIGNATED PART 9, NON-RESIDENTIAL
- 2. ALL WORK SHALL COMPLY WITH (LATEST EDITIONS): A) THE ONTARIO BUILDING CODE (O.B.C.) B) NATIONAL BUILDING CODE (N.B.C.) C) OHSA REGULATIONS
- 3. THESE DRAWINGS ARE FOR STRUCTURAL DESIGN ONLY. INTERIOR FINISHING AND EQUIPMENT TO BE COORDINATED BY SUPPLIER WITH APPROVAL FROM THE OWNER. ALL INTERIOR WORKS TO BE DESIGNED BY SUPPLIER.
- 4. IF DRAWINGS ARE NOT REFLECTIVE OF EXISTING CONDTIONS DESIGNLOGIX IS TO BE NOTIFIED. NO CHANGES SHALL BE MADE WITHOUT THE ENGINEER'S APPROVAL
- 5. CONTRACTOR SHALL MAKE ADEQUATE PROVISIONS FOR TEMPORARY BRACING/SHORING. CONSTRUCITON LOADS SHALL NOT EXCEED THE DESIGN LOADS.
- 6. THIS DRAWING SET IS THE PROPERTY OF DESIGNLOGIX ENGINEERING AND MAY NOT BE DUPLICATED OR SHARED IN ANY FORM WITHOUT WRITTEN CONSENT FROM DESIGNLOGIX ENGINEERING
- 7. PROVIDE STAMPED PRECAST SLATS/WALLS AND TRUSS SHOP DRAWING FOR REVIEW

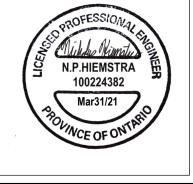GENERAL REVIEW:

- 1. THE ENGINEER SHALL BE CONTACTED BY THE OWNER OR CONTRACTOR TO PERFORM SITE REVIEW OF CONSTRUCTION IN ACCORDANCE WITH O.B.C. 1.2.2.2 (C)
- 2. ENGINEER TO BE CONTACTED (24 HOURS PRIOR) FOR:
- A) FOOTING REVIEW: ONCE EXCAVATION IS COMPLETE AND FORMWORK FOR FOOTING IS COMPLETE B) CONCRETE REVIEW: ONCE REBAR HAD BEEN TIED FOR CONCRETE COMPONENTS
- C) FRAMING REVIEW: PRIOR TO COMMENCEMENT OF INTERIOR FINISHES AND CLADDING D) FINAL REVIEW: UPON COMPLETION OF ALL STRUCTURAL COMPONENTS AND INTERIOR FINISHING

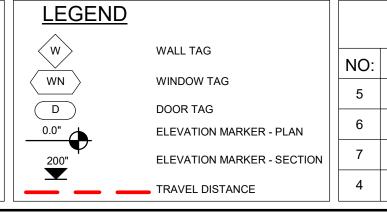EXCAVATION AND BACKFILL:

- 1. FOUNDATIONS HAVE BEEN DESIGNED BASED ON THE ASSUMPTION OF 3000 psf ALLOWABLE BEARING CAPACITY
- 2. ALL UNDERSIDE OF FOOTINGS TO BE 48" BELOW GRADE
- 3. IF SOFT SOILS ARE ENCOUNTERED DURING EXCAVATION NOTIFY ENGINEER BEFORE PROCEEDING WITH CONSTRUCTION. ENGINEER TO BE NOTIFIED FOR (BUT NOT LIMITED TO) CONCERNS REGARDING DRAINAGE, SLOPE STABILITY AND SOIL BEARING CAPACITY
- 4. GRANULAR FILL UNDER FOOTINGS SHALL BE FREE-DRAINING CLEAN GRANULAR "B" MATERIAL OR BETTER AND IS TO BE COMPACTED TO 100% STANDARD PROECTOR DENSITY AT OPTIMUM MOISTURE
- 5. CUT AND CAP OR REROUTE ALL FIELD TILES EXPOSED DURING EXCAVATING
- 6. PROVIDED DEWATERING FACILITIES TO REMOVE AND MAINTAIN WATER LEVEL BELOW FOOTINGS FOR ANY WATER SOURCE ENCOUNTERED DURING CONSTRUCTION
- 7. BACKFILL SHALL BE FREE DRAINING CLEAN GRANULAR FILL. SLOPE GRADE TO DRAIN AWAY FROM BUILDING

CONCRETE:

- 1. SUPPLY AND PLACE CONCRETE AS FOLLOWS: FOOTINGS - 25MPa (3625 psi), MAX W/C RATIO OF 0.55, AIR CONTENT 5% TO 8% FOUNDATION WALLS - 25MPa (3625 psi), MAX W/C RATIO OF 0.50, AIR CONTENT 5% TO 8% CONCRETE FLOORS - 30MPa (4351 psi), MAX W/C RATIO OF 0.45, NO AIR CONTENT REQUIRED U.N.O.
- PIT WALLS & FLOORS (SUBJECT TO ACID ATTACK) 32MPa HS (OR APPROVED EQUIVALENT) CEMENT MAX W/C RATIO OF 0.45, AIR CONTENT 5% TO 8%
- 2. CONCRETE CODES CONFORM TO CSA-A23.1 (LATEST EDITION)
- 3. CONCRETE SLABS TO BE SAW CUT TO 1/4 OF SLAB DEPTH SPACED AT 30 TIMES THE SLAB DEPTH. SAW CUTS TO BE COMPLETED WITHIN 24 HOURS OF SLAB PLACEMENT
- 4. MINIMUM CORNER REINFORCING SHALL BE 24"x24" (600mmx600mm) 'L'-BARS.
- 5. ALL REINFORCEMENT SHALL CONFORM TO CSA G30.3, G30.5 & G30.18 (LATEST EDITION) WITH A YIELD STRENGTH OF 400MPa (58 ksi) FOR DEFORMED BARS OR 448MPa (65 ksi) FOR WELDED WIRE MESH
- 6. MINIMUM COVER ON REINFORCING ON REINFORCING FOR FORMED CONCRETE EXPOSED TO EARTH SHALL BE 2" (50mm) ALL OTHER COMPONENTS SHALL NOT BE LESS THEN 2" (50mm)
- 7. REINFORCING REBAR SPLICES SHALL BE 18" MIN U.N.O.
- 8. ADEQUATE PROTECTION FROM FREEZING MUST BE PROVIDED TO POURED CONCRETE DURING COLD WEATHER

STEEL NOTES:

- 1. ALL STEEL SHALL BE DESIGNED, FABRICATED AND ERECTED IN CONFORITO CAN/CSA-S1/AND O.B.C. LATEST
- 2. ALL STEEL MEMBERS TO BE NEW MEMBERS
- 3. ALL ROLLED STRUCTURAL STEEL MEMBERS SHALL CONFORM TO CSA-G40.20-04/G40.21-04-M300W EXCEPT WIDE FLANGE SECTIONS WHICH SHALL CONFORM TO CSA-G40.20-04/G40.21-04-M350W.
- 4. WELDING SHALL CONFORM TO CSA W59-03 LATEST EDITION. ELECTRODES SHALL BE E70XX OR BETTER
- 5. BOLTS FOR STRUCTURAL STEEL CONNECTIONS SHALL CONFORM TO ASTM A325
- 6. ALL BOLTED CONNECTIONS SHALL BE BEARING TYPE U.N.O.
- 7. ALL CONNECTIONS SHALL BE INSPECTED AS PER CAN/CSA S16-09

WOOD NOTES:

- 1. LUMBER SHALL BE #1 OR #2 SPF OR BETTER U.N.O.
- 2. STUD WALLS SHALL BE ANCHORED TO FOUNDATION WITH 1/2"x8" ANCHORS AT 48" C/C SPACING AND WITHIN 6" OF END OF WALL OR CORNER...
- 3. WIND BRACING TO BE PROVIDED AS DETAILED IN STRUCTURAL DRAWINGS
- 4. CONTRACTOR SHALL ENSURE ANY TEMPORARY BRACING OF WALLS AND TRUSSES ARE ADEQUATE
- 5. STUDS SHALL BE SECURED TO PLATES WITH (3)3 1/4" NAILS
- 6. ALL FASTENERS INTO P.T. LUMBER TO BE STAINLESS OR HOT DIPPED GALVANIZED
- 7. STRUCTURAL WOOD ELEMENTS SHALL BE FABRICATED AND ERECTED IN ACCORDANCE WITH CAN/CSA 086-01 (LATEST EDITION)
- 8. PLYWOOD SHEATHING SHALL CONFORM TO CSA STANDARD 0121-M1978 "DOUGLAS FIR PLYWOOD" AND 0151-M1978 "CANADIAN SOFT WOOD PLYWOOD"
- 9. O.S.B. SHALL CONFORM TO CSA STANDARD CAN3-0437 1-M85 "WAFERBOARD AND STRANDBOARD"
- 10. LVL TO BE 2250FB-1.5E GRADE OR BETTER

CLADDING NOTES:

- 1. CLADDING TO BE MINIMUM 29 GUAGE WITH RIBS SPACED AT 6"-8"
- 2. CLADDING TO BE FASTENED ON RIBS AT 6" CENTERS WITH HEX-HEAD ROOFING SCREWS


DESIGN LOADS:

SNOW DESIGN PARAMETERS Ss=1.9kPa (39.7psf), Sr=0.40kPa (8.35 psf)

(LONDON, ONT)

ROOF SNOW LOAD ULS=1.92kPa (40.1 psf), SLS=1.73kPa (36.1 psf) 0.53kPa (11psf) SEE TRUSS DRAWINGS

ROOF DEAD LOAD WIND LOADS 1/50 - 0.47kPa (9.8psf)

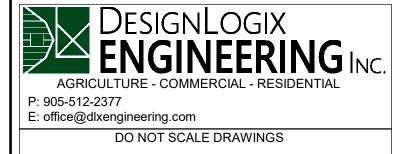

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REPORTED TO THE ENGINEER



<u>ABBREVIATIONS</u>			
@	AT	O.H.	OVERHEAD
c/w	COMPLETE WITH	PF	PAD FOOTING
Ø	DIAMETER	P.T.	PRESSURE TREATED
FDN	FOUNDATION	T.D.	TRAVEL DISTANCE
E.W.	EACH WAY	T&G	TOUNGE & GROOVE
EX.	EXISTING	T/O	TOP OF
HORIZ.	HORIZONTAL	TYP.	TYPICAL
LVL	LAMINATED VENEER LUMBER	U/S	UNDERSIDE
MAX.	MAXIMUM	VERT.	VERTICAL
MIN.	MINIMUM	w/	WITH
ОВС	ONTARIO BUILDING CODE	WWM	WELDED WIRE MESH
c/c	CENTRE TO CENTRE		

<u>LEGEND</u>	
w	WA
WN	WI
D	DO
0.0"	EL
200"	EL
	TR

	<u> </u>
	WALL TAG
	WINDOW TAG
	DOOR TAG
-	ELEVATION MARKER - PLAN
,	ELEVATION MARKER - SECTION
_	TRAVEL DISTANCE

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ONTRACTOR NAME & ADDRESS:				
FOUR SEASONS SUNROOMS				
775 WHARNCLIFFE ROAD SOUTH,				
LONDON ONTARIO				
		7 5		
ROJECT NORTH:	TRUE NORTH:	Project #:	DLX20-439	

Checked by

	PROJECT NAME & ADDRESS:
UNROOMS	MONTEITH SUNF
ROAD SOUTH,	5749 WOODHUI
TARIO	LONDON ON
Project #:	DRAWING TITLE:

OJECT NAME & ADDRESS:	Date
MONTEITH SUNROOM SILO	OCTOBER 13, 2020
5749 WOODHULL ROAD,	Scale
LONDON ONTARIO	

DESIGN NOTES

Sheet No.